

SEPT. 26, 2001 AS SHOWN C. DIEZ 01-08-006.1.DWG 01-08-006 N/A ORDER NO. 01-08-006.1

OF _

REVISIONS 100.01 SITE TO BE FILLED TO DADE COUNTY FLOOD CRITERIA ELEVATION N.G.V.D. OR OR AN ELEVATION NO LESS THAN THE HIGHEST APPROVED CROWN ELEVATION FLOOD LEGEND OF THE ROAD ABUTTING THE PROPERTY. COMPLIANCE WITH CHAPTER IIC OF THE MIAMI DADE COUNTY CODE AREA ADJACENT TO LAKE OR CANAL TO BE GRADED SO AS TO PREVENT SPECIAL FLOOD HAZARD AREA (ZONE AH, AE)- OUTSIDE SPECIAL FLOOD HAZARD AREA (ZONE X) DIRECT OVERLAND DISCHARGE OF STORMMATER INTO LAKE OR CANAL. RESIDENTIAL LOT WILL BE GRADED SO AS TO PREVENT DIRECT OVERLAND DISCHARGE OF STORMWATER ONTO ADJAGENT PROPERTY. APPLICANT WILL PROVIDE CERTIFICATION PRIOR TO FINAL INSPECTION. TENTATIVE PLAT NO. = T-20474 PLAT BOOK HIGHEST CROWN OF ROAD ELEV. HIGHEST CROWN OF ROAD ELEVATION ABOVE WAS TAKEN FROM A CERTIFIED SURVEY PREPARED BY __ PLS LIC.#: ____#4428__ IN ADDITION TO THE REQUIREMENTS OF THIS PERMIT, THERE MAY BE ADDITIONAL RESTRICTIONS APPLICABLE TO THIS PROPERTY THAT MAY BE FOUND IN THE GARAGE/STORAGE | ADJACENT GRADE ELEV. | RETENTION AREA ELEV. LOWEST FLOOR ELEV. PUBLIC RECORDS OF THIS COUNTY. SECTION 553,79(10), FLORIDA STATUTES EXISTING EFFECTIVE 7 /10 /87. PROPOSED A SEPARATE PERMIT WILL BE REQUIRED FOR ALL DRIVEWAY APPROCHES ONTO PUBLIC RIGHT OF WAY. CONTACT PUBLIC WORKS DEPARTMENT. 26'-6-1/2" 26'-6-1/2" THE HEIGHT OF FENCES, WALL AND HEDGES SHALL NOT EXCEED 2.5 FEET In Height within 10 feet of the edge of any driveway leading to a THE BEAM ELEVATION CERTIFICATE IS REQUIRED BEFORE MAKING ANY INSPECTIONS ABOVE THE LOWEST FLOOR AND A FINAL ELEVATION CERTIFICATE IS REQUIRED BEFORE ISSUANCE OF CERTIFICATION OF OCCUPANCY OR COMPLETION (COMPLETION HOLD 186) (1 IC-903) CALL 972-6665. THE HEIGHT OF FENCES IS BEING MEASURED FROM GRADE. O.S.F.H. -(OUTSIDE SPECIAL FLOOD HAZARD) ALL ELECTRICAL, PLUMBING AND MECHANICAL EQUIPMENT MUST BE LOCATED AT OR ABOVE THE REQUIRED LOWEST FLOOR ELEVATION. S.F.H. -(SPECIAL FLOOD HAZARD) ALL ELECTRICAL, PLUMBING AND MECHANICAL EQUIPMENT MUST BE LOCATED AT OR ABOVE GRADE = ELEVATION OF PUBLIC SIDEMALK OR CROWN OF ROAD. THE BASE FLOOD ELEVATION OR THE REQUIRED LOWEST FLOOR ELEVATION WHICHEVER IS HIGHER. LOWEST FLOOR - II C-2(BB) "SHALL MEAN THE LOWEST FLOOR OF THE LOWEST ENCLOSED AREA (INCLUDING BASEMENT). AN UNFINISHED OR FLOOD RESISTANT ENCLOSURE, USABLE FOR PARKING OR VEHICLE, BUILDING ACCESS OR STORAGE IN AN AREA OTHER THAN A BASEMENT AREA, IS NOT CONSIDERED A BUILDING'S LOWEST FLOOR; PROVIDED THAT SUCH ENCLOSURE IS NOT BUILT AS TO RENDER THE STRUCTURE IN VIOLATION OF THE APPLICABLE NON-ELEVATION DESIGN REQUIREMENTS IN 60.9 OF CFR CH.I(IO-I)-88 EDITION)". DADE COUNTY CODE SECTIONS LI C-3,II C-4, II C-5. ______ GARAGE / STORAGE - (SFHA (I I C-5 (F)) FULLY ENCLOSED AREAS BELOW THE BASE FLOOD ELEVATION SHALL BE DESIGNED TO PRECLUDE FINISHED LIVING SPACE EXCEPT ALLOMABLE USES I.E. PARKING, LIMITED STORAGE AND BUILDING ACCESS AND SHALL BE DESIGNED TO ALLOM FOR THE ENTRY AND EXIT _____ OF FLOOD-WATERS TO AUTOMATICALLY EQUALIZE HYDROSTATIC FLOOD FORCES ON EXTERIOR WALLS. THE INTERIOR PORTION OF SUCH ENCLOSED AREA SHA NOT BE PORTIONED OF FINISHED (FLOOD RESISTANT MATERIALS ONLY) INTO SEPARATE ROOMS OR AIR CONDITIONED. DESIGN FOR COMPLYING WITH THIS REQUIREMENT MUST BE EITHER CERTIFIED BY A PROFESSIONAL ENGINEER OR ARCHITECT OR MEET THE FOLLOWING CRITERIA; (I) PROVIDE A MINIMUM OF TWO (2) OPENINGS HAVING A TOTAL NET AREA OF NO LESS THAN ONE (1) SQUARE INCH FOR EVERY SQUARE FOOT OF ENCLOSED AREA SIZE. BOTTOM OF ALL OPENINGS SHALL BE NOT HIGHER THAN ONE (1) FOOT ABOVE GRADE. HIGHEST ADJACENT GRADE - II C-2(Z) "SHALL MEAN THE HIGHEST FINISHED GRADE ELEVATION OF THE GROUND SURFACE NEXT TO THE PROPOSED WALLS OF THE STRUCTURE". I IC-2(66) "MINIMUM FINISHED GRADE SHALL MEAN THE ELEVATION ESTABLISHED IN DADE COUNTY FLOOD CRITERIA MAP AT A SPECIFIC DEVELOPMENT SITE OR CROWN OF ROAD ELEVATION OF AN EXISTING ADJACENT ROAD, WHICHEVER IS HIGHER (OR WAIVER MUST BE OBTAINED). SITE GRADING MUST BE PROVIDED IN A MANNER SO AS TO RETAIN RUN-OFF WITHIN THE SITE AND PREVENT RUN-OFF INTO ADJACENT PROPERTY AS WELL AS DIRECT SURFACE WATER RUN-OFF INTO LAKES OR CANALS. SOIL CONDITION NOTE THE SOIL CONDITIONS AT THIS SITE ARE UNDISTURBED SAND AND ROCK MHICH IS ADEQUATE TO SUPPORT THE DESIGN LOAD OF 2000 PSF. THIS SITE HAS BEEN OBSERVED BY THIS ARCHITECT AND THE FOUNDATION CONDITIONS ARE SIMILAR TO THOSE UPON WHICH THE FOOTING DESIGN IS BASED.. ______} THE FOUNDATION HAS BEEN DESIGNED TO A DESIGN LOAD OF 2000 POUNDS PER A LETTER TO THIS EFFECT WILL BE ISSUED TO THE BUILDING INSPECTOR AT THE TIME OF SLAB INSPECTION, SIGNED AND SEALED BY THE ARCHITECT. FILL REQUIRED FOR SUPPORT OF SLAB ON GRADE CONDITIONS SHALL BE COMPACTED TO 95% OF MAXIMUM DENSITY UNDER THE SUPERVISION OF A SPECIAL INSPECTOR... A LETTER FROM THE SPECIAL INSPECTOR SHALL SUBMITTED TO THE MIAMI-DADE BUILDING INSPECTOR, AT THE TIME OF INSPECTION CENTRAL WATER UNDERGROUND ELEC BY SEWER DISPUSAL SEPTIC TANK ALO LOCATION MAP CENTRAL CLLLECTION SYSTEM 4" TO SEWER SITE PLAN OF I" WATER SERVICE BLACK CREEK ESTATES AND METER LOWEST FLOOR AS-BUILT ELEVATION SURVEY IS REQUIRED BEFORE MAKING ANY INSPECTION ABOVE LOWEST FLOOR "SHALL BE ____ INCHES ABOVE FINISHED GRADE CONTRACTOR SHALL BE 5' SIDEWALK ZONING RU-I RESPONSIBLE FOR THE 5' SIDEWALK BLACK CREEK ESTATES TENTATIVE PLAT 24'-0" HEIGHT TO RIDGE OF ROOF NET LAND AREA OF GAS LINES IN THE PATH OF CONSTRUCTION LOT COVERAGE (EVERYTHING UNDER ROOF) BLACK CREEK ESTATES 25'-1" SETBACKS FRONT 26'- 6 1/2" SITE PLAN SCALE 1/8" 41'-0" 12501 SF LOT AREA LOT COVERAGE SM 200 STREET S.W. 132 AVENUE TYPICAL SITE PLAN TENTATIVE PLAT NO. T-20239 BLACK CREEK ESTATES SUBDIVISION LEGAL DESCRIPTION PLAT BOOK , PAGE PLANNING DEVELOPMENT AND REGULATION DEPARTMENT / BLOCK DADE COUNTY FLORIDA THIS IS AN OFFICIAL APPROVED DRAWING. SEPIAS WILL BE NULL AND VOID IF ALTERED SHEET NO 1 OF 20

SITE TO BE FILLED TO DADE COUNTY FLOOD CRITERIA ELEVATION N.G.V.D. OR OR AN ELEVATION NO LESS THAN THE HIGHEST APPROVED CROWN ELEVATION OF THE ROAD ABUTTING THE PROPERTY. FLOOD LEGEND AREA ADJACENT TO LAKE OR CANAL TO BE GRADED SO AS TO PREVENT COMPLIANCE WITH CHAPTER IIC OF THE MIAMI DADE COUNTY CODE SPECIAL FLOOD HAZARD AREA (ZONE AH, AE)- OUTSIDE SPECIAL FLOOD HAZARD AREA (ZONE X) DIRECT OVERLAND DISCHARGE OF STORMMATER INTO LAKE OR CANAL. LOT WILL BE GRADED SO AS TO PREVENT DIRECT OVERLAND DISCHARGE OF RESIDENTIAL STORMWATER ONTO ADJACENT PROPERTY. APPLICANT WILL PROVIDE CERTIFICATION PRIOR TO FINAL INSPECTION. ____ FOLIO #_ TENTATIVE PLAT NO. = T-20474 ANY APPLICABLE RESOLUTION PLAT BOOK PAGE: HIGHEST CROWN OF ROAD ELEY .: HIGHEST CROWN OF ROAD ELEVATION ABOVE WAS TAKEN FROM A CERTIFIED SURVEY PREPARED BY NOTICE IN ADDITION TO THE REQUIREMENTS OF THIS PERMIT, THERE MAY BE ADDITIONAL LOUIS J. LEERON __ PLS LIC.#: ___#4428__ RESTRICTIONS APPLICABLE TO THIS PROPERTY THAT MAY BE FOUND IN THE LOWEST FLOOR ELEV. GARAGE/STORAGE ADJACENT GRADE ELEV. RETENTION AREA ELEV. PUBLIC RECORDS OF THIS COUNTY. SECTION 553.79(10), FLORIDA STATUTES EXISTING EFFECTIVE 7 /10 /87. PROPOSED A SEPARATE PERMIT WILL BE REQUIRED FOR ALL DRIVEWAY APPROCHES ONTO 9.42' PUBLIC RIGHT OF WAY. CONTACT PUBLIC WORKS DEPARTMENT. THE HEIGHT OF FENCES, MALL AND HEDGES SHALL NOT EXCEED 25 PEET In Height within 10 feet of the edge of any driveway leading to a 24'-5" THE BEAM ELEVATION CERTIFICATE IS REQUIRED BEFORE MAKING ANY INSPECTIONS ABOVE THE LONEST FLOOR AND A FINAL ELEVATION CERTIFICATE 24'-6" RIGHT OF WAY. IS REQUIRED BEFORE 198UANCE OF CERTIFICATION OF OCCUPANCY OR COMPLETION (COMPLETION HOLD 186) (1 IC-9DB) CALL 972-6685. THE HEIGHT OF FENCES IS BEING MEASURED FROM GRADE. O.S.F.H. - (OUTSIDE SPECIAL FLOOD HAZARD) ALL ELECTRICAL, PLUMBING AND MECHANICAL EQUIPMENT MUST BE LOCATED AT OR ABOVE THE REQUIRED GRADE = ELEVATION OF PUBLIC SIDEMALK OR CROWN OF ROAD. LONEST FLOOR ELEVATION. S.F.H. (SPECIAL FLOOD HAZARD) ALL ELECTRICAL, PLUMBING AND MECHANICAL EQUIPMENT MUST BE LOCATED AT OR ABOVE THE BASE FLOOD ELEVATION OR THE REQUIRED LOWEST FLOOR ELEVATION WHICHEVER IS HIGHER. \mathcal{U} LOWEST FLOOR - 11 C-2(BB) "SHALL MEAN THE LOWEST FLOOR OF THE LOWEST ENCLOSED AREA (INCLUDING BAGEMENT). AN UNFINISHED OR FLOOD RESISTANT ENCLOSURE, USABLE FOR PARKING OR VEHICLE, BUILDING ACCESS OR STORAGE IN AN AREA OTHER THAN A BASEMENT AREA, IS NOT CONSIDERED A EUILDING'S LOWEST FLOOR, PROVIDED THAT SUCH ENCLOSURE IS NOT BUILT AS TO RENDER THE STRUCTURE IN VIOLATION OF THE APPLICABLE NON-ELEVATION DESIGN REQUIREMENTS IN 60.9 OF CFR CH.I(IO-I)-88 EDITION)". DADE COUNTY CODE SECTIONS LI C-8, II C-5. GARAGE / STORAGE - (SFHA (I I C-5 (F)) FULLY ENCLOSED AREAS BELOW THE BASE FLOOD ELEVATION SHALL BE DESIGNED TO PRECLUDE FINISHED LIVING SPACE EXCEPT ALLOWABLE USES I.E. PARKING, LIMITED STORAGE AND BUILDING ACCESS AND SHALL BE DESIGNED TO ALLOW FOR THE ENTRY AND EXIT OF FLOOD-MATERS TO AUTOMATICALLY EQUALIZE HYDROSTATIC FLOOD FORCES ON EXTERIOR MALLS. THE INTERIOR PORTION OF SUCH ENCLOSED AREA SHA NOT BE PORTIONED OF FINISHED (FLOOD RESISTANT MATERIALS ONLY) INTO SEPARATE ROOMS OR AIR CONDITIONED. DESIGN FOR COMPLYING WITH THIS REQUIREMENT MUST BE EITHER CERTIFIED BY A PROFESSIONAL ENGINEER OR ARCHITECT OR MEET THE FOLLOWING CRITERIA; (1) PROVIDE A MINIMUM OF TWO (2) OPENINGS HAVING A TOTAL NET AREA OF NO LESS THAN ONE (1) SQUARE INCH FOR EVERY SQUARE FOOT OF ENCLOSED AREA SIZE. BOTTOM OF ALL OPENINGS SHALL BE NOT HIGHER THAN ONE (1) FOOT ABOVE GRADE. HIGHEST ADJACENT GRADE - II C-2(Z) "SHALL MEAN THE HIGHEST FINISHED GRADE ELEVATION OF THE GROUND SURFACE NEXT TO THE PROPOSED WALLS OF THE STRUCTURE". I IC-2(GG) "MINIMUM FINISHED GRADE SHALL MEAN THE ELEVATION ESTABLISHED IN DADE COUNTY FLOOD CRITERIA MAP AT A SPECIFIC DEVELOPMENT SITE OR CROWN OF ROAD ELEVATION OF AN EXISTING ADJACENT ROAD, WHICHEVER IS HIGHER (OR WAIVER MUST BE OBTAINED). SITE GRADING MUST BE PROVIDED IN A MANNER SO AS TO RETAIN RUN-OFF WITHIN THE SITE AND PREVENT RUN-OFF INTO ADJACENT PROPERTY AS WELL AS DIRECT SURFACE WATER RUN-OFF INTO LAKES OR CANALS. SOIL CONDITION NOTE THE SOIL CONDITIONS AT THIS SITE ARE UNDISTURBED SAND AND ROCK WHICH IS ADEQUATE TO SUPPORT THE DESIGN LOAD OF 2000 PSF. THIS SITE HAS BEEN OBSERVED BY THIS ARCHITECT AND THE FOUNDATION CONDITIONS ARE SIMILAR TO THOSE UPON WHICH THE FOOTING DESIGN IS BASED. THE FOUNDATION HAS BEEN DESIGNED TO A DESIGN LOAD OF 2000 POUNDS PER SQUARE FOOT. A LETTER TO THIS EFFECT WILL BE ISSUED TO THE BUILDING INSPECTOR AT THE TIME OF SLAB INSPECTION, SIGNED AND SEALED BY THE ARCHITECT. FILL REQUIRED FOR SUPPORT OF SLAB ON GRADE CONDITIONS SHALL BE COMPACTED TO 45% OF MAXIMUM DENSITY UNDER THE SUPERVISION OF A SPECIAL INSPECTOR... A LETTER TOTAL STORY FROM THE SPECIAL INSPECTOR SHALL SUBMITTED TO THE MIAMI-DADE BUILDING INSPECTOR, AT CONC sph. UNDERGROUND ELEC BY SITE LOCATION 10.0' 17' DRIVE CONTRACTOR SHALL BE 3//4" MATER ! NE RESPONSIBLE FOR THE LOCATION "Shall be ___ inches above finished grade AND ME ER OF GAS LINES IN THE PATH OF CONSTRUCTION 100.01 BLACK CREEK ESTATES TENTATIVE PLAT ZONING RU-1 5' SIDEWALK HEIGHT TO RIDGE OF ROOF 5' SIDEWALK NET LAND AREA BLACK CREEK ESTATES LOT COVERAGE (EVERYTHING UNDER ROOF) SETBACKS PRONT ____24'-4" SOURCE OF WATER - WELL SIDE STREET SITE PLAN CENTRAL WATER 48-9" LOT AREA 12501 SF SCALE 1/8" =1'-0" LOT COVERAGE SEWER DISPUSAL SEPTIC TANK SM 200 STREET CENTRAL CLLECTION SYSTEM S.W. 132 AVENUE TYPICAL SITE PLAN VALENCIA GROVE ESTATES SUBDIVISION LEGAL DESCRIPTION () tr 3-13-01 VALENCIA GROVE ESTATES TENTATIVE PLAT NUMBER = T- 20474 TENTATIVE PLAT NO. T - 20474 SM 203 STREET BLOCK D, DE COUNTY FLORIDA ENERGY SHEET NO I-A PLANNING DEVELOPMENT AND REGULATION DEPARTMENT THIS IS AN OFFICIAL APPROVED DRAWING. SEPIAS WILL BE NULL AND VOID IF ALTERED

SITE TO BE FILLED TO DADE COUNTY FLOOD CRITERIA ELEVATION N.S.Y.D. OR OR AN ELEVATION NO LESS THAN THE HIGHEST APPROVED CROWN ELEVATION OF THE ROAD ABUTTING THE PROPERTY.

AREA ADJACENT TO LAKE OR CANAL TO BE GRADED SO AS TO PREVENT DIRECT OVERLAND DISCHARGE OF STORMWATER INTO LAKE OR CANAL. LOT WILL BE GRADED SO AS TO PREVENT DIRECT OVERLAND DISCHARGE OF STORMWATER ONTO ADJACENT PROPERTY.

APPLICANT WILL PROVIDE CERTIFICATION PRIOR TO FINAL INSPECTION.

ANY APPLICABLE RESOLUTION

BLACK CREEK ESTATES TENTATIVE PLAT

VALENCIA GROVE ESTATES
TENTATIVE PLAT
NUMBER = T- 20474

SW 200 STREET

SW 200 TERRACE

SW 203 STREET

IN ADDITION TO THE REQUIREMENTS OF THIS PERMIT, THERE MAY BE ADDITIONAL RESTRICTIONS APPLICABLE TO THIS PROPERTY THAT MAY BE FOUND IN THE PUBLIC RECORDS OF THIS COUNTY. SECTION 553.79(10), FLORIDA STATUTES EFFECTIVE 7 /10 /87.

A SEPARATE PERMIT WILL BE REQUIRED FOR ALL DRIVEWAY APPROCHES ONTO PUBLIC RIGHT OF WAY. CONTACT PUBLIC WORKS DEPARTMENT. THE HEIGHT OF PENCES, WALL AND HEDGES SHALL NOT EXCEED 25 FEET IN HEIGHT WITHIN IO FEET OF THE EDGE OF ANY DRIVEWAY LEADING TO A RIGHT OF WAY.

THE HEIGHT OF FENCES IS BEING MEASURED FROM GRADE.

GRADE = ELEVATION OF PUBLIC SIDEMALK OR CROWN OF ROAD.

FLOOD LEGEND COMPLIANCE WITH CHAPTER IIC OF THE MIAMI DADE COUNTY CODE SPECIAL FLOOD HAZARD AREA (ZONE AH, AE)- OUTSIDE SPECIAL FLOOD HAZARD AREA (ZONE X)

PROCESS #			TENTATIVE PLAT NO. = T-20474	
		1		
ADDRESS.		,		
			taken from a certified !	ELEV.; SURVEY PREPARED BY
Hic	SHEST CROWN OF ROAD EL	EVATION ABOVE WAS		SURVEY PREPARED BY
Hic	SHEST CROWN OF ROAD EL	EVATION ABOVE WAS	TAKEN FROM A CERTIFIED	SURVEY PREPARED BY
Hic	SHEST CROWN OF ROAD EL J. LEBRON	EVATION ABOVE WAS	TAKEN FROM A CERTIFIED 9	SURVEY PREPARED BY

THE BEAM ELEVATION CERTIFICATE IS REQUIRED BEFORE MAKING ANY INSPECTIONS ABOVE THE LOWEST FLOOR AND A FINAL ELEVATION CERTIFICATE 15 REQUIRED BEFORE ISSUANCE OF CERTIFICATION OF OCCUPANCY OR COMPLETION (COMPLETION HOLD 186) (1 IC-3D3) CALL 372-6685.

O.S.F.H. -(OUTSIDE SPECIAL FLOOD HAZARD) ALL ELECTRICAL, PLUMBING AND MECHANICAL EQUIPMENT MUST BE LOCATED AT OR ABOVE THE REQUIRED LOWEST FLOOR ELEVATION. S.F.H. -(SPECIAL FLOOD HAZARD) ALL ELECTRICAL, PLUMBING AND MECHANICAL EQUIPMENT MUST BE LOCATED AT OR ABOVE THE BASE FLOOD ELEVATION OR THE REQUIRED LOWEST FLOOR ELEVATION WHICHEVER IS HIGHER.

LONEST FLOOR - 11 C-2(BB) "SHALL MEAN THE LOWEST FLOOR OF THE LOWEST ENCLOSED AREA (INCLUDING BASEMENT). AN UNFINISHED OR FLOOD RESISTANT ENCLOSURE, USABLE FOR PARKING OR VEHICLE, BUILDING ACCESS OR STORAGE IN AN AREA OTHER THAN A BASEMENT AREA, IS NOT CONSIDERED A BUILDING'S LOWEST FLOOR; PROVIDED THAT SUCH ENCLOSURE IS NOT BUILT AS TO RENDER THE STRUCTURE IN VIOLATION OF THE APPLICABLE NON-ELEVATION DESIGN REQUIREMENTS IN 60.3 OF CFR CH.I(IO-I)-66 EDITION)". DADE COUNTY CODE SECTIONS LI C-3,II C-4, II C-5.

GARAGE / STORAGE - (SFHA (I I C-5 (F)) FULLY ENCLOSED AREAS BELOW THE BASE FLOOD ELEVATION SHALL BE DESIGNED TO PRECLUDE FINISHED LIVING SPACE EXCEPT ALLOWABLE USES I.E. PARKING, LIMITED STORAGE AND BUILDING ACCESS AND SHALL BE DESIGNED TO ALLOW FOR THE ENTRY AND EXIT OF FLOOD-WATERS TO AUTOMATICALLY EQUALIZE HYDROSTATIC FLOOD FORCES ON EXTERIOR WALLS. THE INTERIOR PORTION OF SUCH ENCLOSED AREA SHA NOT BE PORTIONED OF FINISHED (FLOOD RESISTANT MATERIALS ONLY) INTO SEPARATE ROOMS OR AIR CONDITIONED. DESIGN FOR COMPLYING WITH THIS REQUIREMENT MUST BE EITHER CERTIFIED BY A PROFESSIONAL ENGINEER OR ARCHITECT OR MEET THE FOLLOWING CRITERIA; (I) PROVIDE A MINIMUM OF TWO (2) OPENINGS HAVING A TOTAL NET AREA OF NO LEGS THAN ONE (1) SQUARE INCH FOR EVERY SQUARE FOOT OF ENCLOSED AREA SIZE. BOTTOM OF ALL OPENINGS SHALL BE NOT HIGHER THAN ONE (1) FOOT ABOVE GRADE.

HIGHEST ADJACENT GRADE - II C-2(Z) "SHALL MEAN THE HIGHEST FINISHED GRADE ELEVATION OF THE GROUND SURFACE NEXT TO THE PROPOSED WALLS OF THE STRUCTURE". I IC-2(66) "MINIMUM FINISHED GRADE SHALL MEAN THE ELEVATION ESTABLISHED IN DADE COUNTY FLOOD CRITERIA MAP AT A SPECIFIC DEVELOPMENT SITE OR CROWN OF ROAD ELEVATION OF AN EXISTING ADJACENT ROAD, WHICHEVER IS HIGHER (OR WAIVER MUST BE OBTAINED). SITE GRADING MUST BE PROVIDED IN A MANNER SO AS TO RETAIN RUN-OFF WITHIN THE SITE AND PREVENT RUN-OFF INTO ADJACENT PROPERTY AS WELL AS DIRECT SURFACE WATER RUN-OFF INTO LAKES OR CANALS.

SOIL CONDITION NOTE THE SOIL CONDITIONS AT THIS SITE ARE UNDISTURBED SAND AND ROCK WHICH IS ADEQUATE TO SUPPORT THE DESIGN LOAD OF 2000 PSF. THIS SITE HAS BEEN OBSERVED BY THIS ARCHITECT AND THE FOUNDATION CONDITIONS ARE SIMILAR TO THOSE UPON WHICH THE FOOTING DESIGN IS BASED. THE FOUNDATION HAS BEEN DESIGNED TO A DESIGN LOAD OF 2000 POUNDS PER SQUARE FOOT. A LETTER TO THIS EFFECT WILL BE ISSUED TO THE BUILDING INSPECTOR AT THE TIME OF SLAB INSPECTION, SIGNED AND SEALED BY THE ARCHITECT. FILL REQUIRED FOR SUPPORT OF SLAB ON GRADE CONDITIONS SHALL BE COMPACTED TO 95% OF MAXIMUM DENSITY UNDER THE SUPERVISION OF A SPECIAL INSPECTOR... A LETTER FROM THE SPECIAL INSPECTOR SHALL SUBMITTED TO THE MIAMI-DADE BUILDING INSPECTOR, AT THE TIME OF INSPECTION

district <u>ah</u> City Flood Cr	DISTRICT_AH CITY FLOOD CRITERIA 9.0°		1 <i>00</i>
DRISTICTS	CNN	9FH.	OTHER
REGURED	/		
PROPOSED *		10.0'	

ZONING RU - 1 HEIGHT TO RIDGE OF ROOF NET LAND AREA BLACK CREEK ESTATES LOT COVERAGE (EVERYTHING UNDER ROOF) LOT AREA LOT COVERAGE

YALENCIA GROVE ESTATES

SITE LOCATION

METRO DADE	APPROVED FOR	- DATE
BLDG.	1 Mile	03/15/
STRU.		2/2/-
PŁUM.	<u> </u>	13/13/0
elec.		
MECH.		
ENERGY	14.00 m	
PLANNING DEV	ELOPMENT AND REGU AN OFFICIAL APPRO VILL BE NULL AND V	VED DRAWING


12501 SF 22.1%

	APPROVED FOR MASTER MODEL		
VETTO SAGE	1 By	DATE	
BLDG.	5/Mh	03/15/0	
STRU.		30.30	
PŁUM.	1	[3/13/0]	
elec.			
MECH.			
ENERGY	Ng s		
ATIO IS V	LOPMENT AND REGU N OFFICIAL APPRO ILL BE NULL AND V	LATION DEPARTMENT VED DRAWING	

LEGAL DESCRIPTION

BLOCK

DADE COUNTY FLORIDA

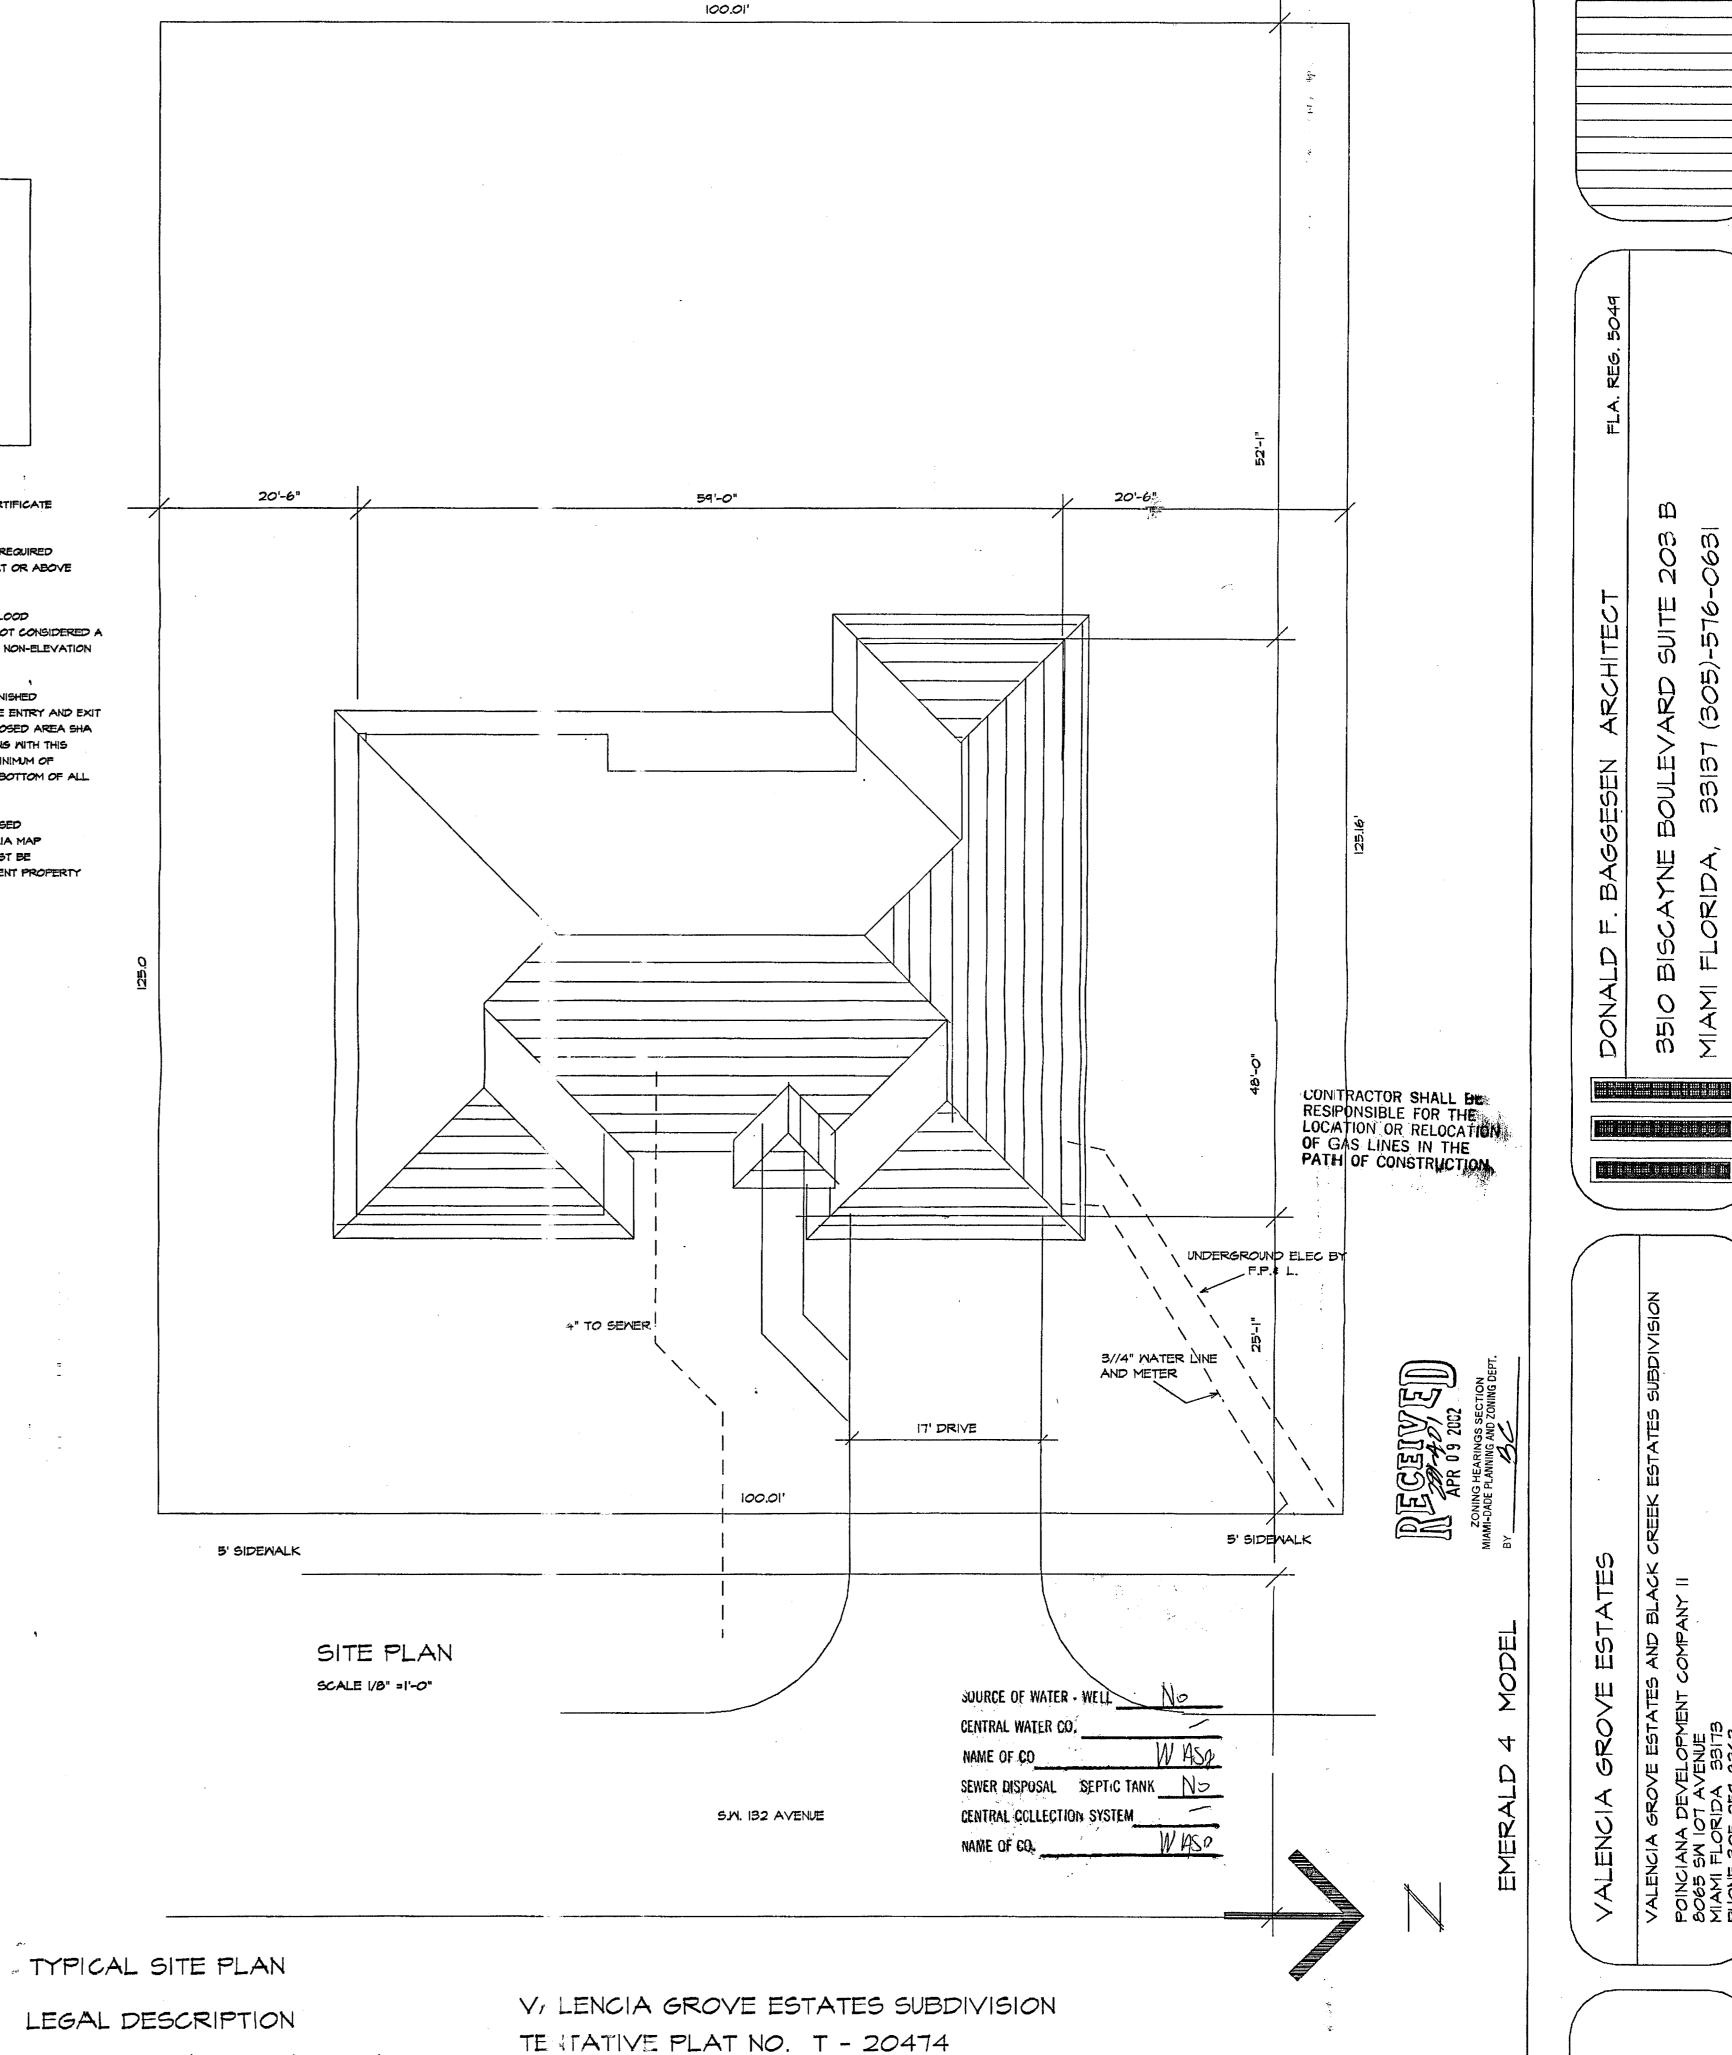

REVISIONS

But the find the district the five

SHEET NO I-A

OF 20

REVISIONS SITE TO BE FILLED TO DADE COUNTY FLOOD CRITERIA ELEVATION N.S.Y.D. OR OR AN ELEVATION NO LESS THAN THE HIGHEST APPROVED CROWN ELEVATION FLOOD LEGEND OF THE ROAD ABUTTING THE PROPERTY. COMPLIANCE WITH CHAPTER IIC OF THE MIAMI DADE COUNTY CODE AREA ADJACENT TO LAKE OR CANAL TO BE GRADED SO AS TO PREVENT SPECIAL FLOOD HAZARD AREA (ZONE AH, AE)- OUTSIDE SPECIAL FLOOD HAZARD AREA (ZONE X) DIRECT OVERLAND DISCHARGE OF STORMWATER INTO LAKE OR CANAL. RESIDENTIAL LOT WILL BE GRADED SO AS TO PREVENT DIRECT OVERLAND DISCHARGE OF STORMWATER ONTO ADJACENT PROPERTY. APPLICANT WILL PROVIDE CERTIFICATION PRIOR TO FINAL INSPECTION. TENTATIVE PLAT NO. = T-20474 ANY APPLICABLE RESOLUTION HIGHEST CROWN OF ROAD ELEY. HIGHEST CROWN OF ROAD ELEVATION ABOVE WAS TAKEN FROM A CERTIFIED SURVEY PREPARED BY PLS LIC.#1 #4428 IN ADDITION TO THE REQUIREMENTS OF THIS PERMIT, THERE MAY BE ADDITIONAL RESTRICTIONS APPLICABLE TO THIS PROPERTY THAT MAY BE FOUND IN THE LONEST FLOOR ELEY. GARAGE/STORAGE | ADJACENT GRADE ELEY. | RETENTION AREA ELEY. PUBLIC RECORDS OF THIS COUNTY. SECTION 559.79(10), FLORIDA STATUTES EXISTING EFFECTIVE 7 /10 /87. PROPOSED A SEPARATE PERMIT WILL BE REQUIRED FOR ALL DRIVEWAY APPROCHES ONTO PUBLIC RIGHT OF WAY. CONTACT PUBLIC WORKS DEPARTMENT. THE HEIGHT OF FENCES, WALL AND HEDGES SHALL NOT EXCEED 2.5 FEET In Height within 10 feet of the edge of any driveway leading to a THE BEAM ELEVATION CERTIFICATE IS REQUIRED BEFORE MAKING ANY INSPECTIONS ABOVE THE LOWEST FLOOR AND A FINAL ELEVATION CERTIFICATE IS REQUIRED BEFORE ISSUANCE OF CERTIFICATION OF OCCUPANCY OR COMPLETION (COMPLETION HOLD 186) (I IC-3D3) CALL 372-6685. RIGHT OF WAY. THE HEIGHT OF FENCES IS BEING MEASURED FROM GRADE. O.S.F.H. -(OUTSIDE SPECIAL FLOOD HAZARD) ALL ELECTRICAL, PLUMBING AND MECHANICAL EQUIPMENT MUST BE LOCATED AT OR ABOVE THE REQUIRED GRADE = ELEVATION OF PUBLIC SIDEMALK OR CROWN OF ROAD. LONEST FLOOR ELEVATION. S.F.H. -(SPECIAL FLOOD HAZARD) ALL ELECTRICAL, PLUMBING AND MECHANICAL EQUIPMENT MUST BE LOCATED AT OR ABOVE THE BASE FLOOD ELEVATION OR THE REQUIRED LOWEST FLOOR ELEVATION WHICHEVER IS HIGHER. LOWEST FLOOR - II C-2(BB) "SHALL MEAN THE LOWEST FLOOR OF THE LOWEST ENCLOSED AREA (INCLUDING BASEMENT). AN UNFINISHED OR FLOOD RESISTANT ENCLOSURE, USABLE FOR PARKING OR VEHICLE, BUILDING ACCESS OR STORAGE IN AN AREA OTHER THAN A BASEMENT AREA, IS NOT CONSIDERED A BUILDING'S LOWEST FLOOR, PROVIDED THAT SUCH ENCLOSURE IS NOT BUILT AS TO RENDER THE STRUCTURE IN VIOLATION OF THE APPLICABLE NON-ELEVATION DESIGN REQUIREMENTS IN 60.9 OF CFR CH.I(IO-I)-88 EDITION)". DADE COUNTY CODE SECTIONS LI C-9,II C-4, II C-5. GARAGE / STORAGE - (SFHA (I I C-5 (F)) FULLY ENCLOSED AREAS BELOW THE BASE FLOOD ELEVATION SHALL BE DESIGNED TO PRECLUDE FINISHED OF FLOOD-WATERS TO AUTOMATICALLY EQUALIZE HYDROSTATIC FLOOD FORCES ON EXTERIOR WALLS. THE INTERIOR PORTION OF SUCH ENCLOSED AREA SHA NOT BE PORTIONED OF FINISHED (FLOOD RESISTANT MATERIALS ONLY) INTO SEPARATE ROOMS OR AIR CONDITIONED. DESIGN FOR COMPLYING MITH THIS REGUIREMENT MUST BE EITHER CERTIFIED BY A PROFESSIONAL ENGINEER OR ARCHITECT OR MEET THE FOLLOWING CRITERIA; (i) PROVIDE A MINIMUM OF THO (2) OPENINGS HAVING A TOTAL NET AREA OF NO LESS THAN ONE (1) SQUARE INCH FOR EVERY SQUARE FOOT OF ENCLOSED AREA SIZE. BOTTOM OF ALL OPENINGS SHALL BE NOT HIGHER THAN ONE (I) FOOT ABOVE GRADE. HIGHEST ADJACENT GRADE - II C-2(Z) "SHALL MEAN THE HIGHEST FINISHED GRADE ELEVATION OF THE GROUND SURFACE NEXT TO THE PROPOSED MALLS OF THE STRUCTURE". I IC-2(GG) "MINIMUM FINISHED GRADE SHALL MEAN THE ELEVATION ESTABLISHED IN DADE COUNTY FLOOD CRITERIA MAP AT A SPECIFIC DEVELOPMENT SITE OR CROWN OF ROAD ELEVATION OF AN EXISTING ADJACENT ROAD, WHICHEVER IS HIGHER (OR WAIVER MUST BE OBTAINED). SITE GRADING MUST BE PROVIDED IN A MANNER SO AS TO RETAIN RUN-OFF WITHIN THE SITE AND PREVENT RUN-OFF INTO ADJACENT PROPERTY AS MELL AS DIRECT SURFACE WATER RUN-OFF INTO LAKES OR CANALS. SOIL CONDITION NOTE THE SOIL CONDITIONS AT THIS SITE ARE UNDISTURBED SAND AND ROCK MHICH IS ADEQUATE TO SUPPORT THE DESIGN LOAD OF 2000 PSF. THIS SITE HAS BEEN OBSERVED BY THIS ARCHITECT AND THE FOUNDATION CONDITIONS ARE SIMILAR TO THOSE UPON WHICH THE FOOTING DESIGN IS BASED. _____ THE FOUNDATION HAS BEEN DESIGNED TO A DESIGN LOAD OF 2000 POUNDS PER SQUARE FOOT. A LETTER TO THIS EFFECT WILL BE ISSUED TO THE BUILDING INSPECTOR AT THE TIME OF SLAB INSPECTION, SIGNED AND SEALED BY THE ARCHITECT. FILL REQUIRED FOR SUPPORT OF SLAB ON GRADE CONDITIONS SHALL BE COMPACTED TO 959 e ber a demarkanya ya ya k OF MAXIMUM DENSITY UNDER THE SUPERVISION OF A SPECIAL INSPECTOR.. A LETTER FROM THE SPECIAL INSPECTOR SHALL SUBMITTED TO THE MIAMI-DADE BUILDING INSPECTOR, AT UNDERGROUND ELEC BY 4" TO SEMER CONTRACTOR SHALL BE RESPONSIBLE FOR THE LOCATION I" MATER LINE CHN брн AND METER OF GAS LINES IN THE SITE LOCATION PATH OF CONSTRUCTION 10.0 17' DRIVE LONEST FLOOR AS-BUILT ELEVATION SURVEY IS REQUIRED BEFORE MAKING ANY INSPECTION ABOVE LONEST FLOOR SHALL BE ___ INCHES ABOVE PINISHED GRADE 100.01 BLACK CREEK ESTATES TENTATIVE PLAT 5' SIDEMALK ZONING RU - I 5' SIDEWALK 16'-0" HEIGHT TO RIDGE OF ROOF NET LAND AREA BLACK CREEK ESTATES LOT COVERAGE (EVERYTHING UNDER ROOF) SOURCE OF WATER - WELL SETBACKS FRONT SITE PLAN "CENTRAL WATER CO. SIDE STREET SCALE 1/8" =1'-0" 12501 SF LOT AREA SEWER DISPUSAL SEPTIC TANK LOT COVERAGE CENTRAL CELLECTION SYSTEM SM 200 STREET S.M. 182 AVENUE VALENCIA GROVE ESTATES TYPICAL SITE PLAN VALENCIA GROVE ESTATES SUBDIVISION LEGAL DESCRIPTION TENTATIVE PLAT NO. T - 20474 VALENCIA GROVE ESTATES
TENTATIVE PLAT
NUMBER = T- 20474 LOT BLOCK DADE COUNTY FLORIDA PLANNING DEVELOPMENT AND REGULATION DEPARTMENT THIS IS AN OFFICIAL AFFRAVED BRAWING, SHEET NO I-A BEPIAS WILL BE NULL AND VOID IF ALTERED OF 19